Plans for North Applications Planning Committee

5th March 2015





Report of the Head of Planning, Sport and Green Spaces

Address BISHOP RAMSEY C OF E SCHOOL HUME WAY RUISLIP

Development: Installation of 6 floodlight columns (12m high) located evenly around the

external perimeter of the Multi Use Games Area.

LBH Ref Nos: 19731/APP/2015/47

Date Plans Received: 07/01/2015 Date(s) of Amendment(s):

Date Application Valid: 07/01/2015

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SITE BOUNDARY





PLANNING

92

NEW FLOODLIGHTS TO EXISTING MUGA BISHOP RAMSEY CE SCHOOL HUME WAY RUISLIP HA4 8EE

THE GOVERNORS

LOCATION PLAN



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DECEMBER 2014	1:1250 @ A1	3113/2/PD1

Games Court Bishop Ramsey C of E School FB COLLEGE DRIVE

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OVERALL BOUNDARY OF OWNERSHIP

SITE BOUNDARY

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PLANNING

NEW FLOODLIGHTS TO EXISTING MUGA BISHOP RAMSEY CE SCHOOL HUME WAY RUISLIP HA4 8EE

THE GOVERNORS


BLOCK PLAN



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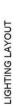
FOR FURTHER DETAILS RELATING TO THE PROPOSED FLOODLIGHTS PLEASE REFER TO DOCUMENTATION PROVIDED BY ABACUS LIGHTING LTD

92

PLANNING

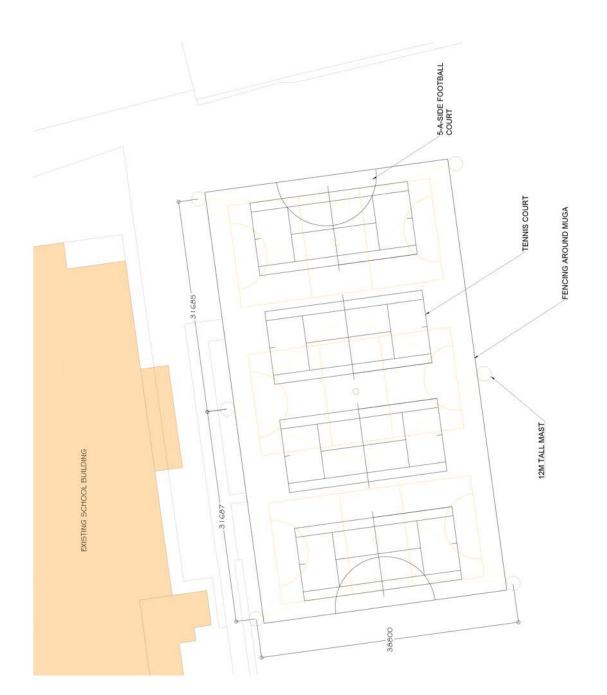NEW FLOODLIGHTS TO EXISTING MUGA BISHOP RAMSEY CE SCHOOL HUME WAY RUISLIP HA4 8EE

THE GOVERNORS





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DECEMBER 2014	1:200 @ A1
	DECEMBER 2014 LT

3113/2/PD3



FLOODLIGHTING EQUIPMENT:

EACH CARRYING THE FOLLOWING FLOODLIGHTS: 6 X 12M MASTS (M1-M6)

M1-M6.....2 X AL5780/2KWMH-TS2000W/XL

BACK SHIELDS ADDED TO MAST 3 & 6

LAMPS (VENTURE): 2KW/MH-TS 2000W/XL/K12/74 (240 000 INITIAL Lm)

ILLUMINANCE LEVELS: INITIAL (100 HRS)

E.I.AVE = 532 LUX

MAINTAINED (4000 HRS) E.M.AVE = 410 LUX

9

50/25

516

15

528 595 594

516

586

604 1611

536 505

959 059

621

613

516

481 ,374 ,381 ,435 ,375

552 518 567

569 515 550

53

511

526

591

591

85

25,50

10

UNIFORMITY

EMIN/EAVE = 0.70

GRID VALUES IN LUX GRID INTERVAL = 5M MAINTENANCE FACTOR = 0.80

M3 12m

M2 12m

52

481

699

550 515 568

528 52p

567 518 552

612

498

626 649

536

\$05

CONTOURS 2,5,10,25,50 LUX CONTOUR VALUES IN LUX

SUPPLY THE COLUMN AND OR MAST LOCATIONS IN CONJUNCTION WITH THE FLOODLIGHT AIMING UPON RECEIPT OF YOUR ORDER ABACUS WILL



Sutton-in-Ashfield, Nottinghamshire ABACUS LIGHTING LTD. Fax: (+44) 01623 552133 Tel: (+44) 01623 511111 NG17 5FT England

Lighting Project: Ruislip Bishop Ramsey School

Title: 400Lux FLOODLIGHTING


UKS9576 Design Ref:


Revision(s) From Previous Design:

Scale: 1:500 @ A3 Design By: JOE WITTON Date: 09/10/2014

Email: light@abacus-lighting.com

All illuminance values are the result of computer calculations, based upon precisely positioned luminaires in a fixed relationship to each other and to the area under examination. In practice the values may vary due to tolerances on luminaires, luminaire positioning, reflection properties and electrical supply.

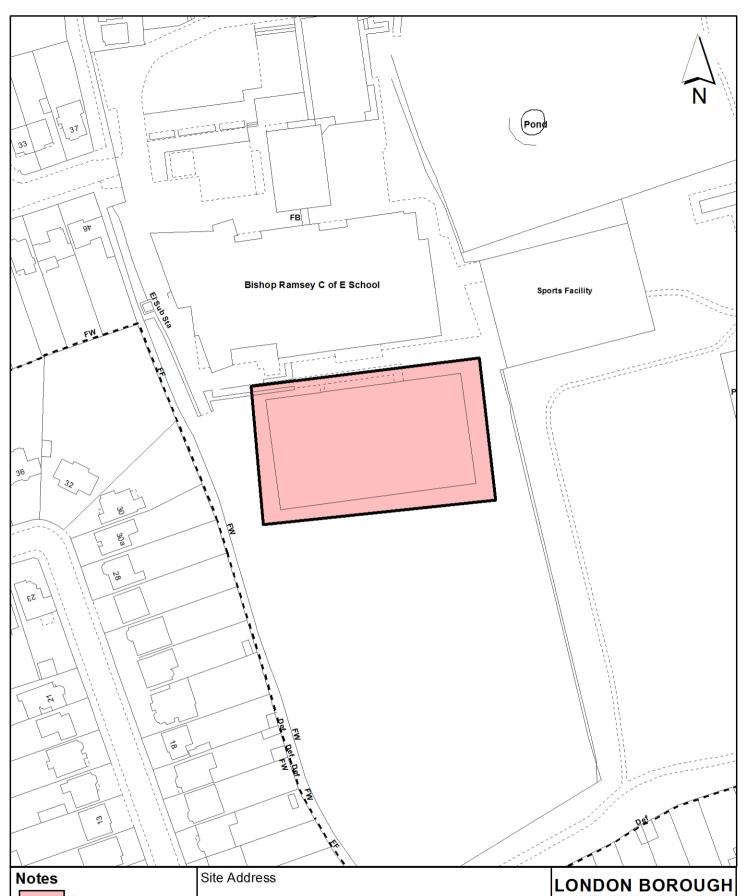

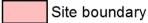

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Bishop Ramsey C of E School Hume Way Ruislip

Planning Application Ref: 19731/APP/2015/47	Scale 1:1,250
Planning Committee	Date
North	March 2015



OF HILLINGDON

Residents Services

Planning Section

Civic Centre, Uxbridge, Middx. UB8 1UW

Telephone No.: Uxbridge 250111

Report of the Head of Planning, Sport and Green Spaces

Address REAR OF 103 FIELD END ROAD EASTCOTE


Development: Three storey, 2-bed detached dwelling with associated parking and amenity

space

LBH Ref Nos: 70463/APP/2014/4205

Date Plans Received: 27/11/2014 Date(s) of Amendment(s): 12/12/2014

Date Application Valid: 16/12/2014 27/11/2014

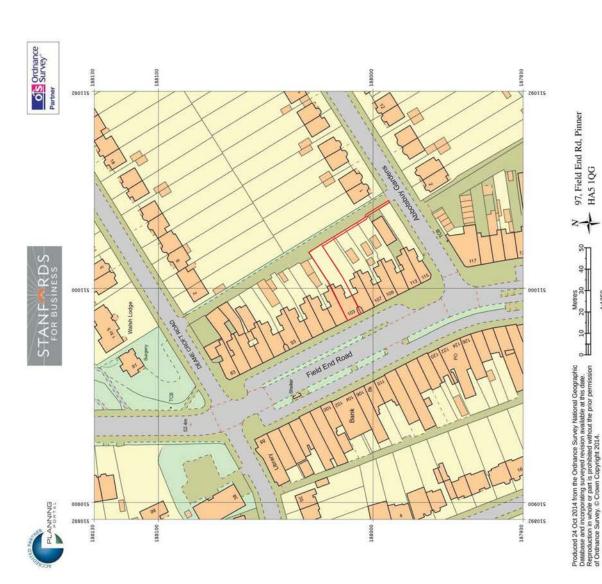

1:1250 @ A3 140827 13/11/14 P1-001 AB

> 103 Field End Road, Eastcote Project title

Location Plan Sheet name

Supplied by: Stanfords 24 Oct 2014 Stanfords Ordnance Survey Partner Licence: 100035409 Order Licence Reference: 01773901 Centre coordinates: 510992 188030

The representation of a road, track or path is no evidence of a right of way. The representation of features as lines is no evidence of a property boundary. Ordnance Survey and the OS Symbol are registered trademarks of Ordnance Survey, the national mapping agency of Great Britain.

Project number Drawn by Checked by Date






1:500 @ A3 140827 13/1/1/14 P1-010 AB Scale

Project number
Date
Drawn by
Checked by

Site Plan - Existing

Sheet name

Project title 103 Field End Road, Eastcote

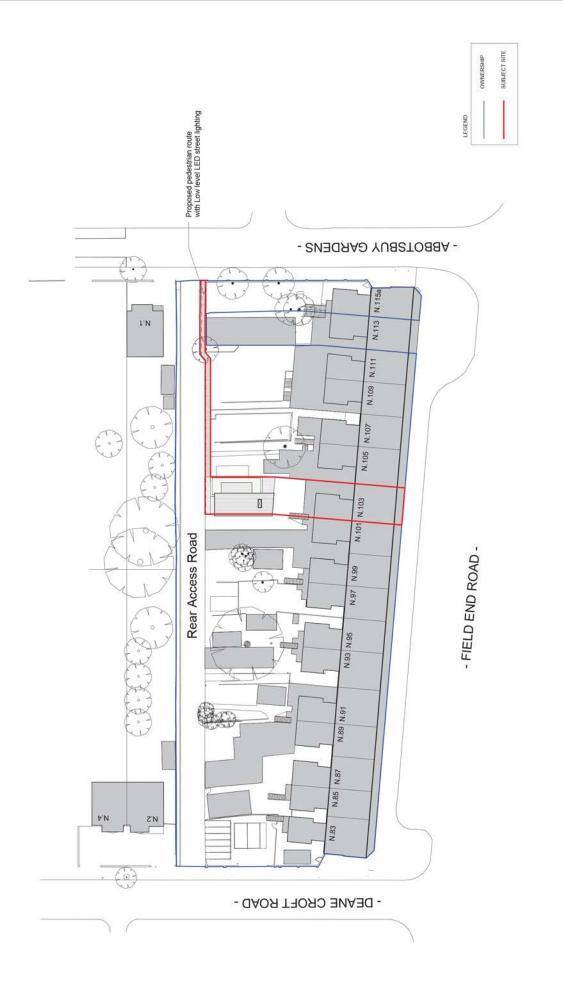


103 Field End Road, Eastcote Project title


Site Plan - Proposed Sheet name


1:500 @ A3

140827 13/1/1/14 P1-110 AB Scale


Project number Date Drawn by Checked by

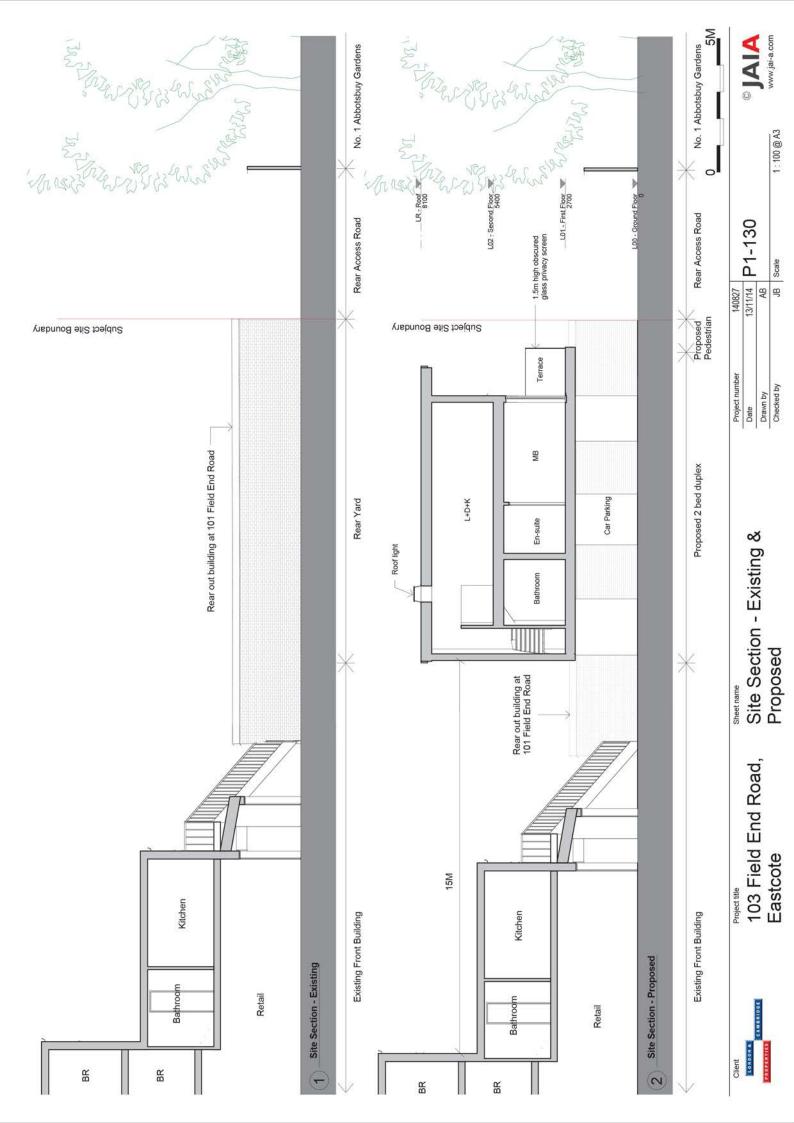


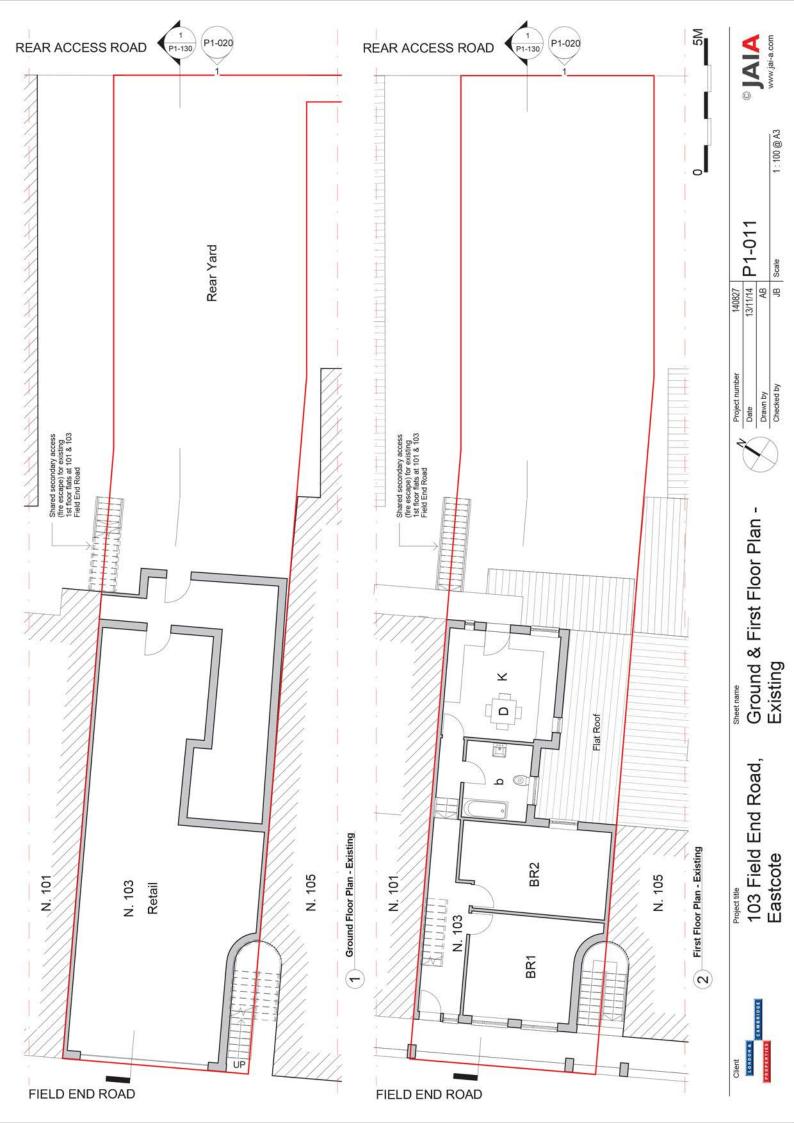


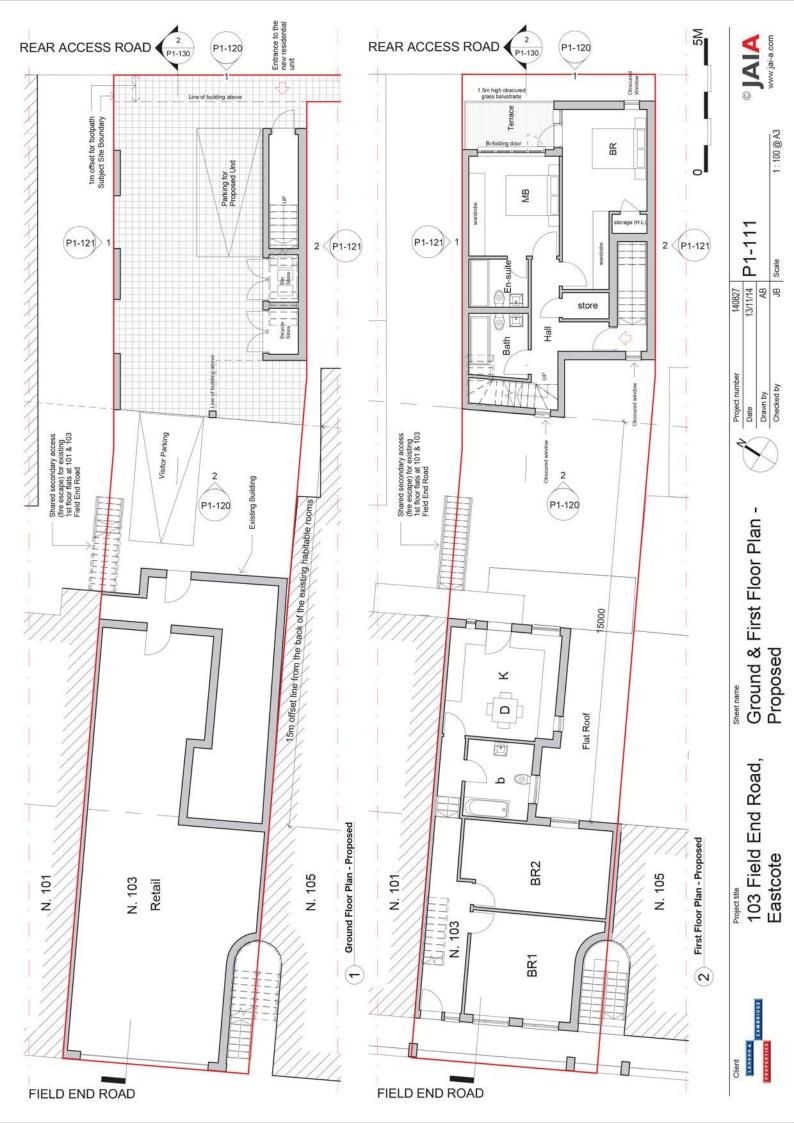



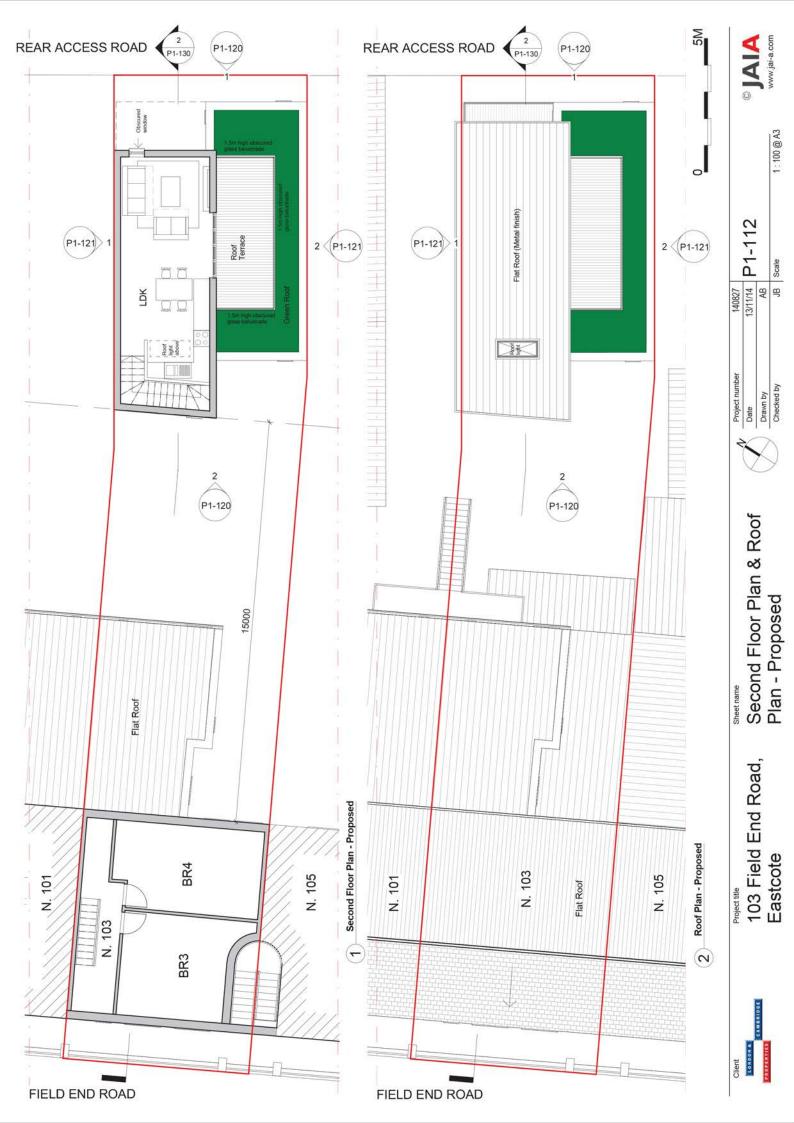

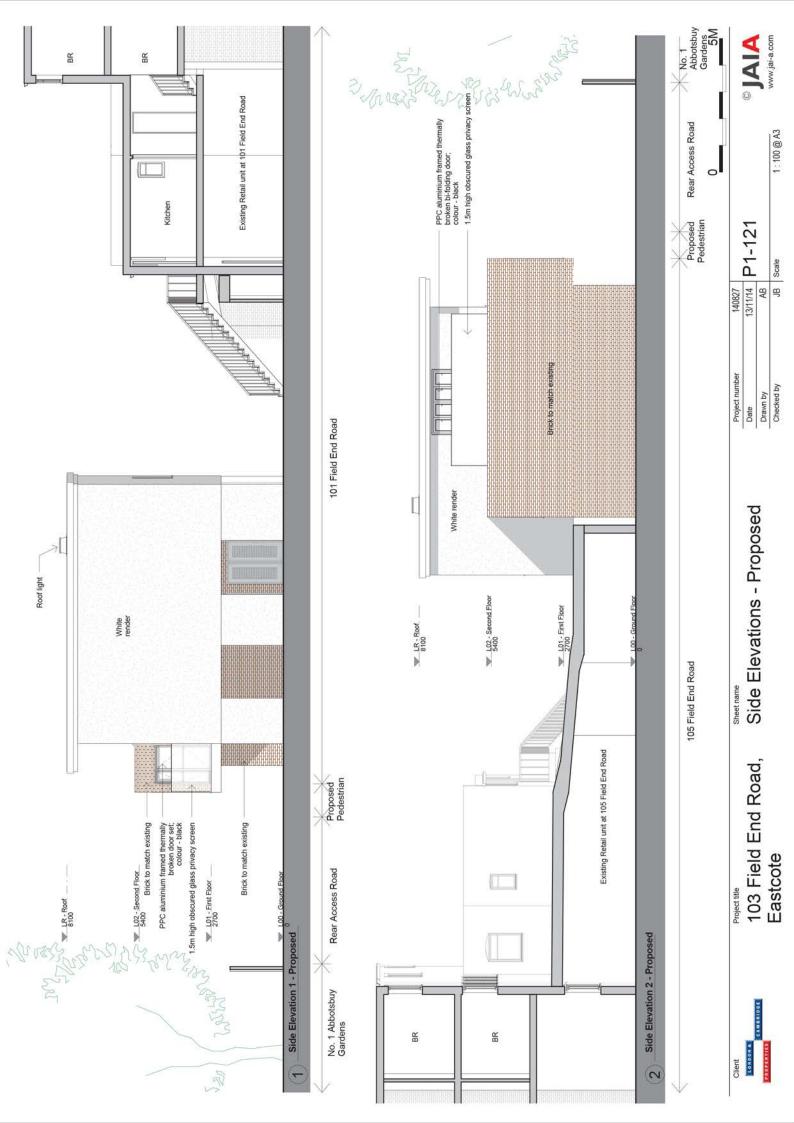

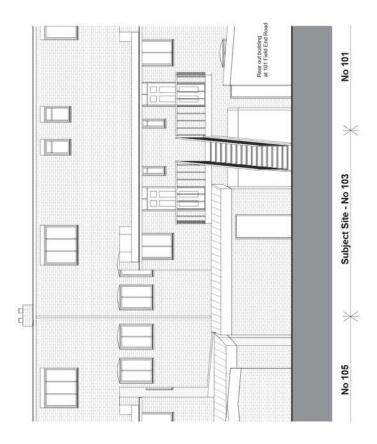

Rear Access Road Elevation - Existing

SM

Road Elev

Sheet name Rear Acc Existing


Project title 103 Field End Road, Eastcote


Client



13/11/14 P1-020
AB Scale

Project number
Date
Drawn by
Checked by

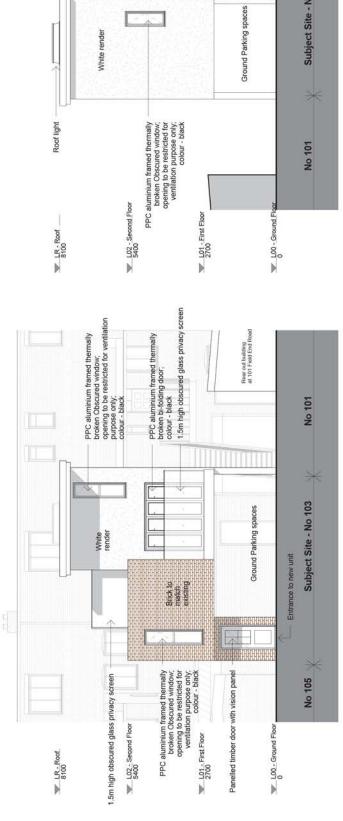

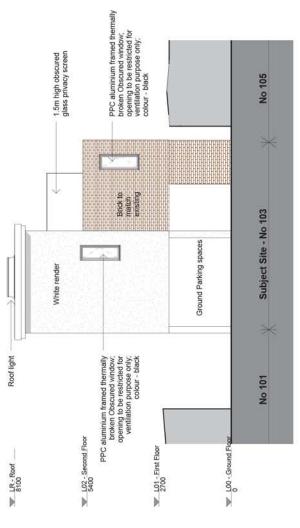

Checked by Drawn by Date Rear Access Road & Court Yard Elevation - Proposed







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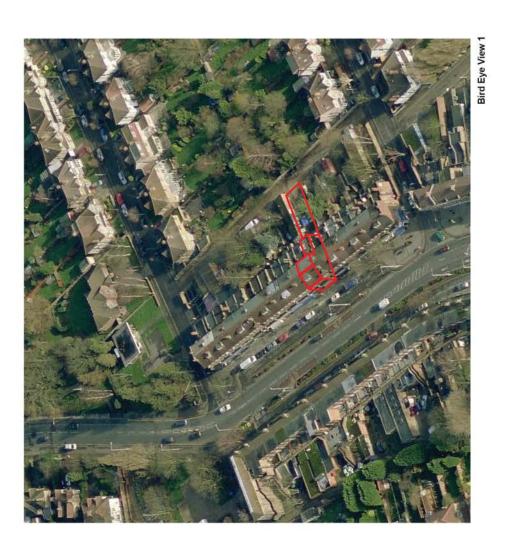
Court Yard Elevation - Proposed

(7)

(1) Rear Access Road Elevation - Proposed

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Sheet name





Bird Eye View 2




Site Photographic Survey 1





@ A3



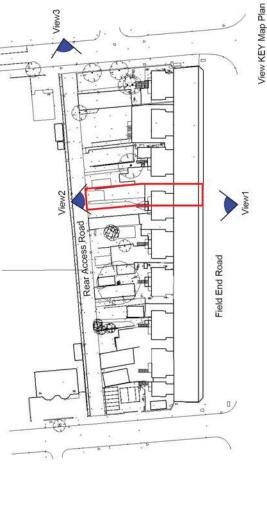












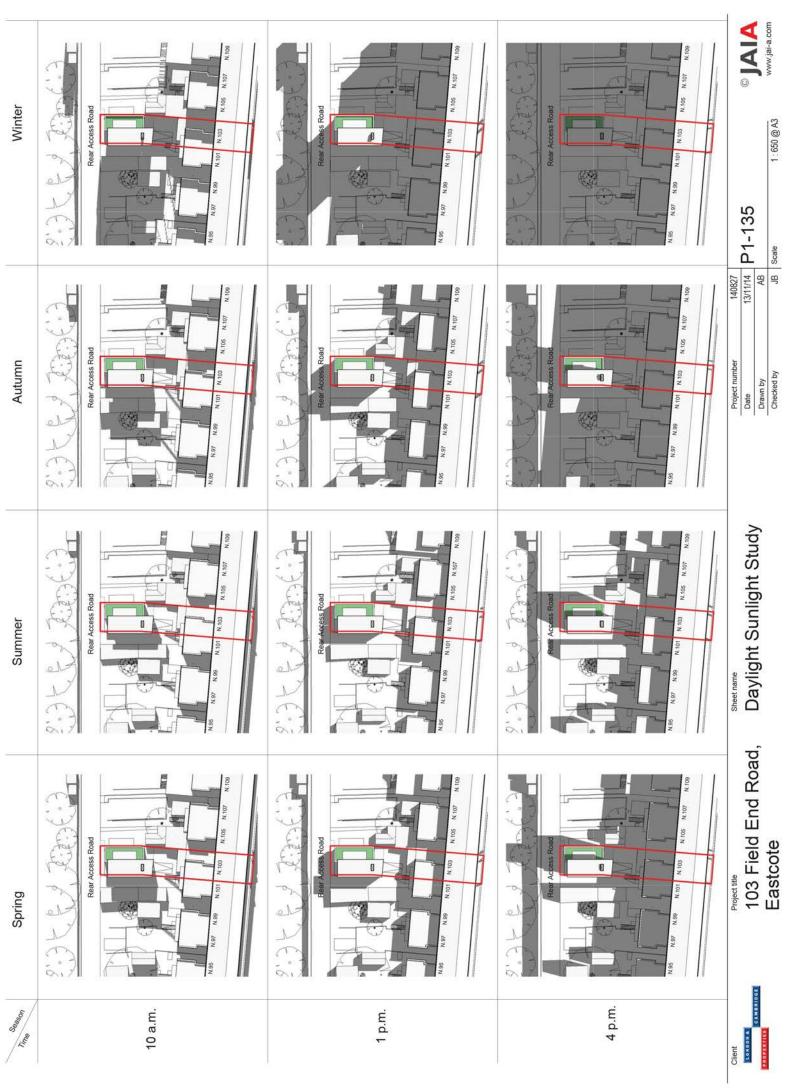



Daylight Sunlight Study

1:650 @ A3



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Rear of 103 Field End Road Eastcote

Planning Application Ref:

70463/APP/2014/4205

Planning Committee

Scale

1:1,250

North

March 2015

Residents Services Planning Section

Civic Centre, Uxbridge, Middx. UB8 1UW Telephone No.: Uxbridge 250111



Report of the Head of Planning, Sport and Green Spaces

Address 151 WOODLANDS AVENUE RUISLIP

Development: Conversion of two storey dwelling into 3 x 2-bed self contained flats with


associated parking and amenity space involving two storey side extension and first floor rear extension, conversion of roofspace to habitable use to include a rear dormer, 1 front rooflight and conversion of roof from hip to gable end and

installation of 2 x vehicular crossovers to front

LBH Ref Nos: 41208/APP/2014/4035

Date Plans Received: 13/11/2014 Date(s) of Amendment(s): 13/11/0014

Date Application Valid: 14/11/2014

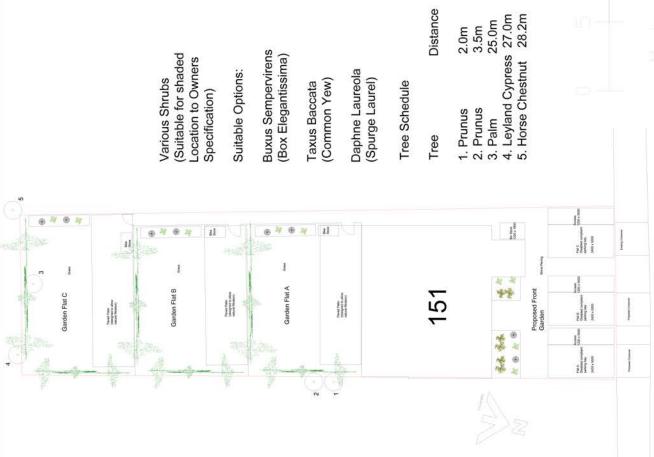

Various Shrubs (Suitable for shaded Location to Owners Specification)

Suitable Options:

Buxus Sempervirens (Box Elegantissima)

Taxus Baccata (Common Yew)

Daphne Laureola (Spurge Laurel)

Tree Schedule

Distance


(Scale 1:200) Site Plan

Woodlands Avenue



Location Plan (Scale 1:1250)

iDesign UK Consultancy		- As Proposed	REV REV	VVA/2014/10	SHEET
iDesign UK	TITLE	Site & Location Plan - As Proposed	SIZE CAGE CODE DWG NO	A3	SCALE 1:200 & 1:1250
151 Woodlands Avenue Eastcote Middlesex	HA4 9QX			October 2014	

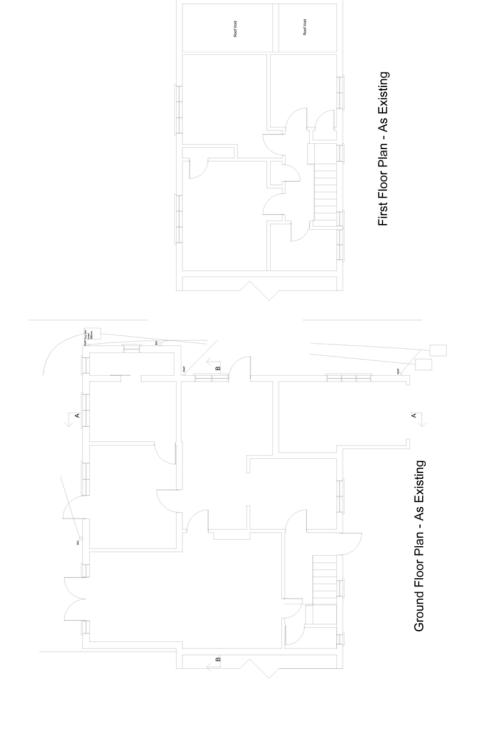


iDesign UK Consultancy


Ground Floor Plan - As Existing 151 Woodlands Avenue Eastcote Middlesex HA4 9QX

SIZE A3 CAGE CODE DWG NO WA/2014/01 SCALE 1:100 SHEET October 2014

REV

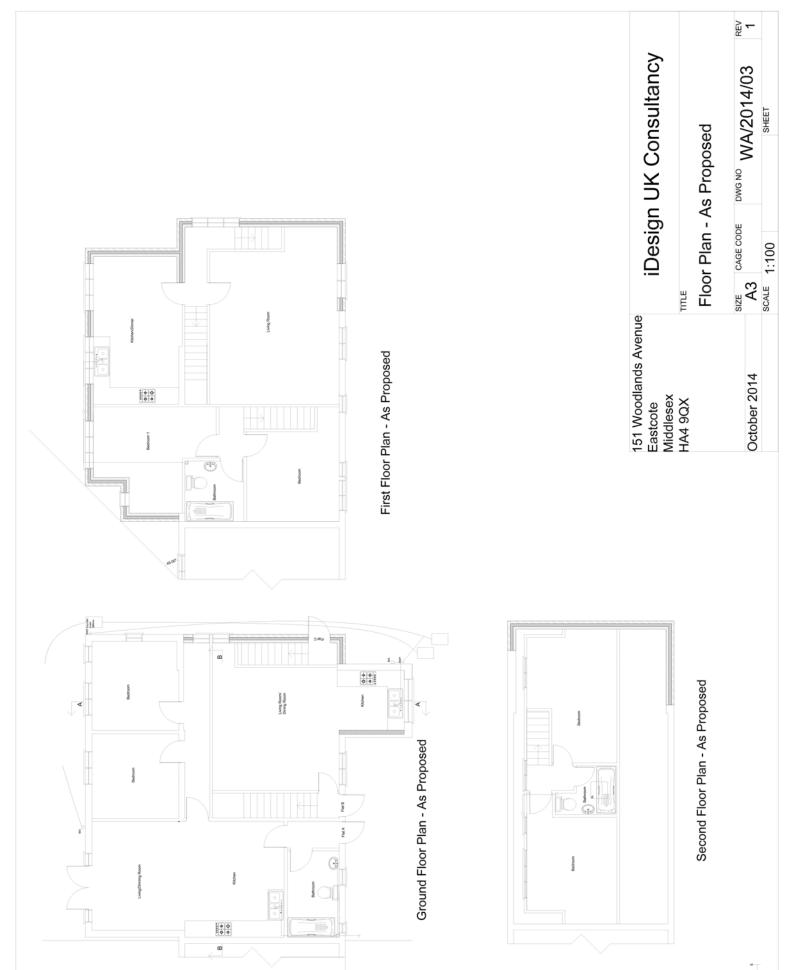

Notes

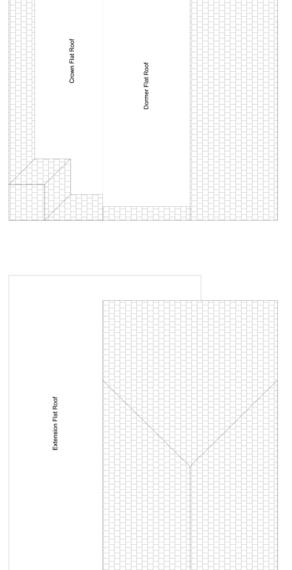

Roof Framing Plan - As Proposed


Roof Framing Plan - As Existing


151 Woodlands Avenue iDesign UK Consultancy
Middlesex
HA4 9QX
Roof Framing Plan - Existing & Proposed
Size CAGE CODE
October 2014
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SCALE 1:100
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SCALE 1:100

SHEET




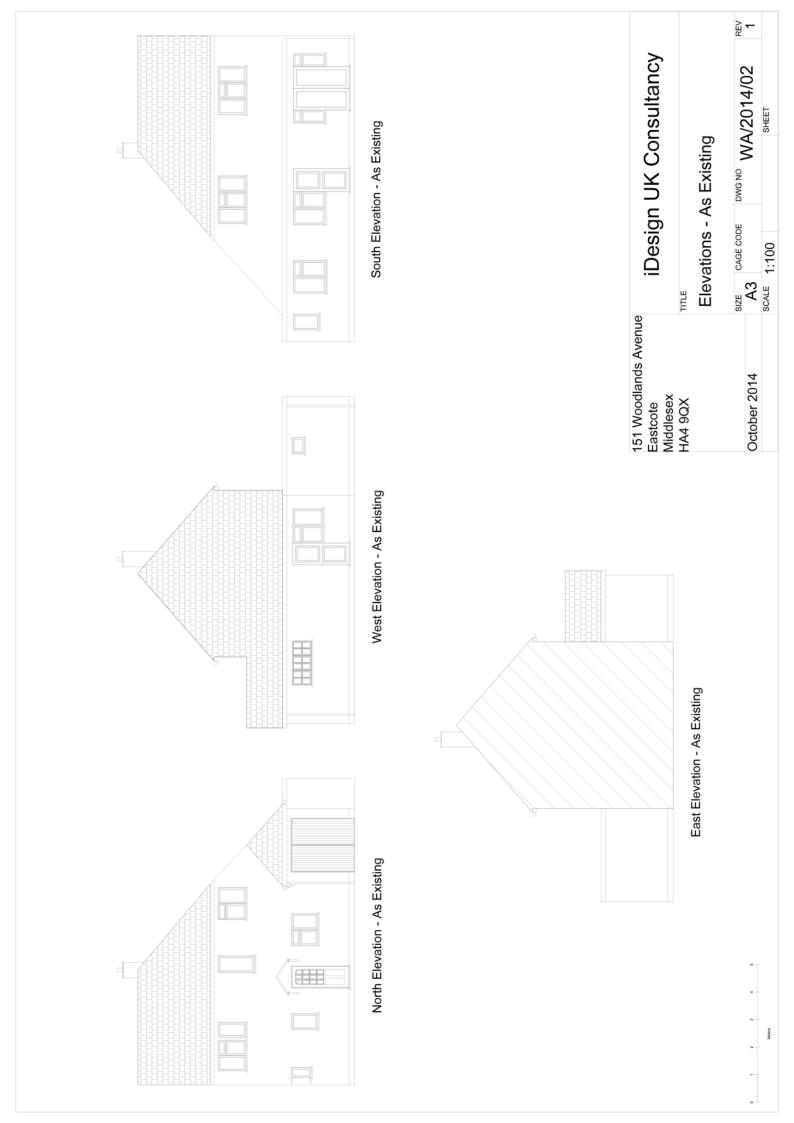



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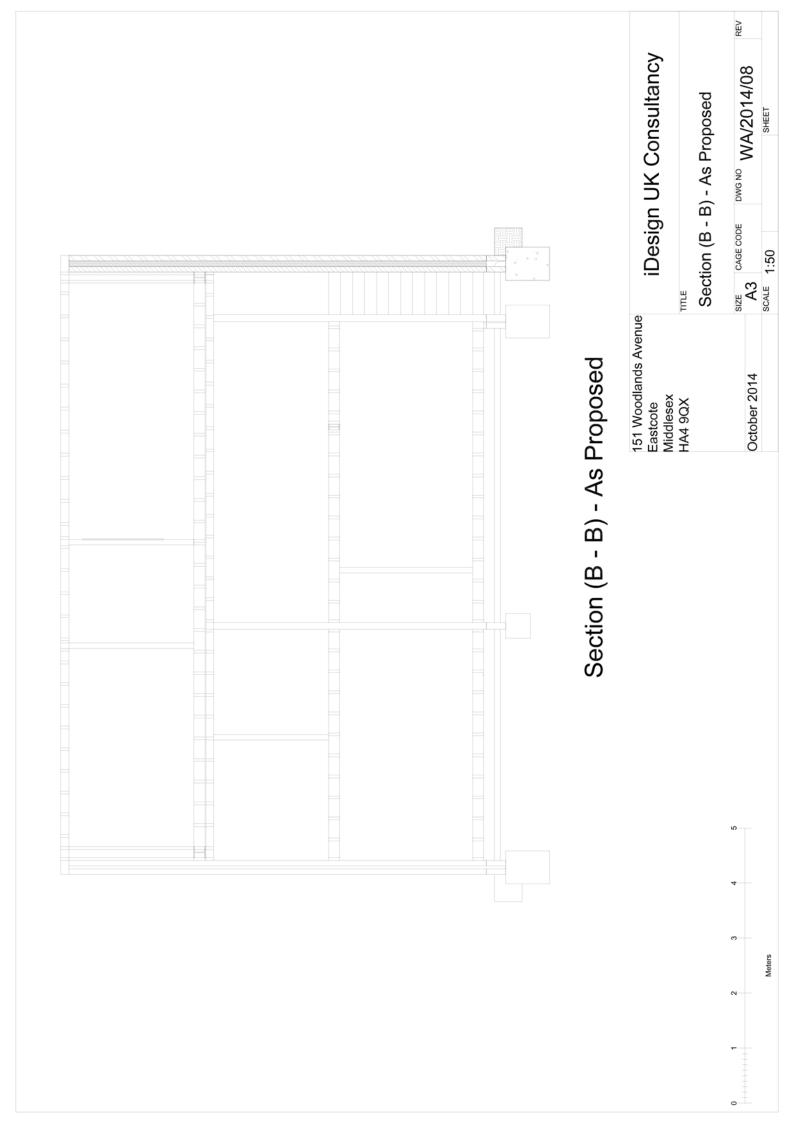
SCALE 1:100

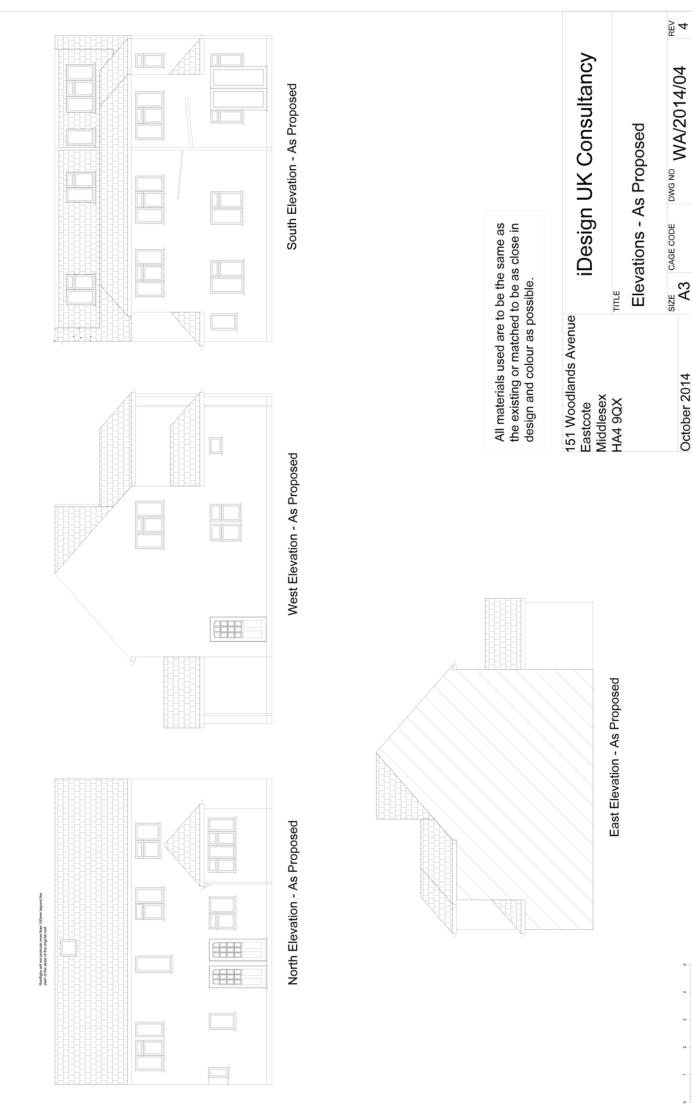October 2014




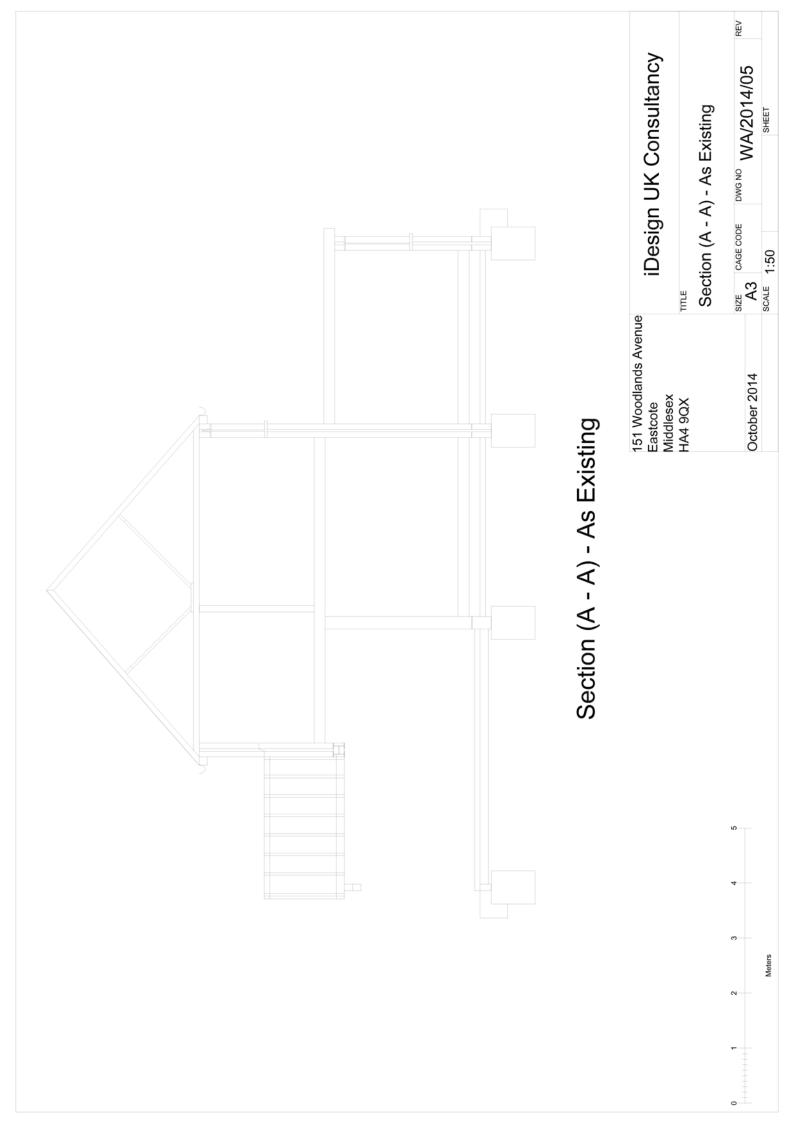

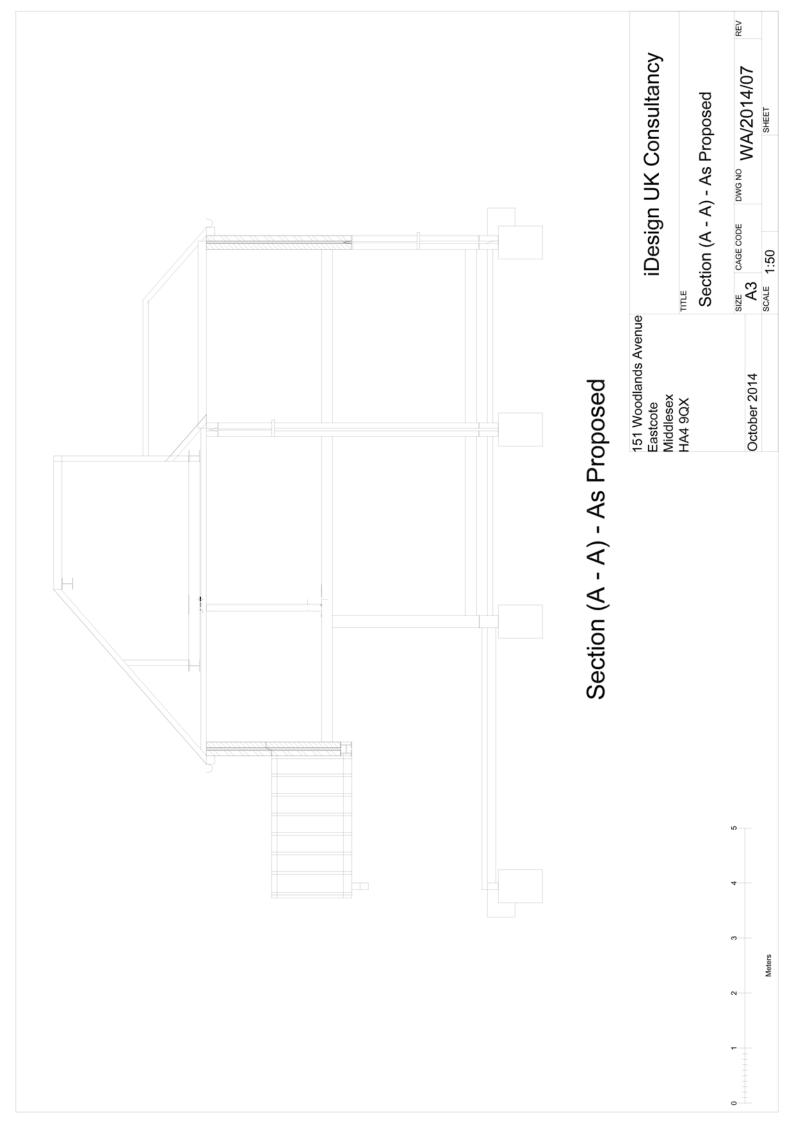

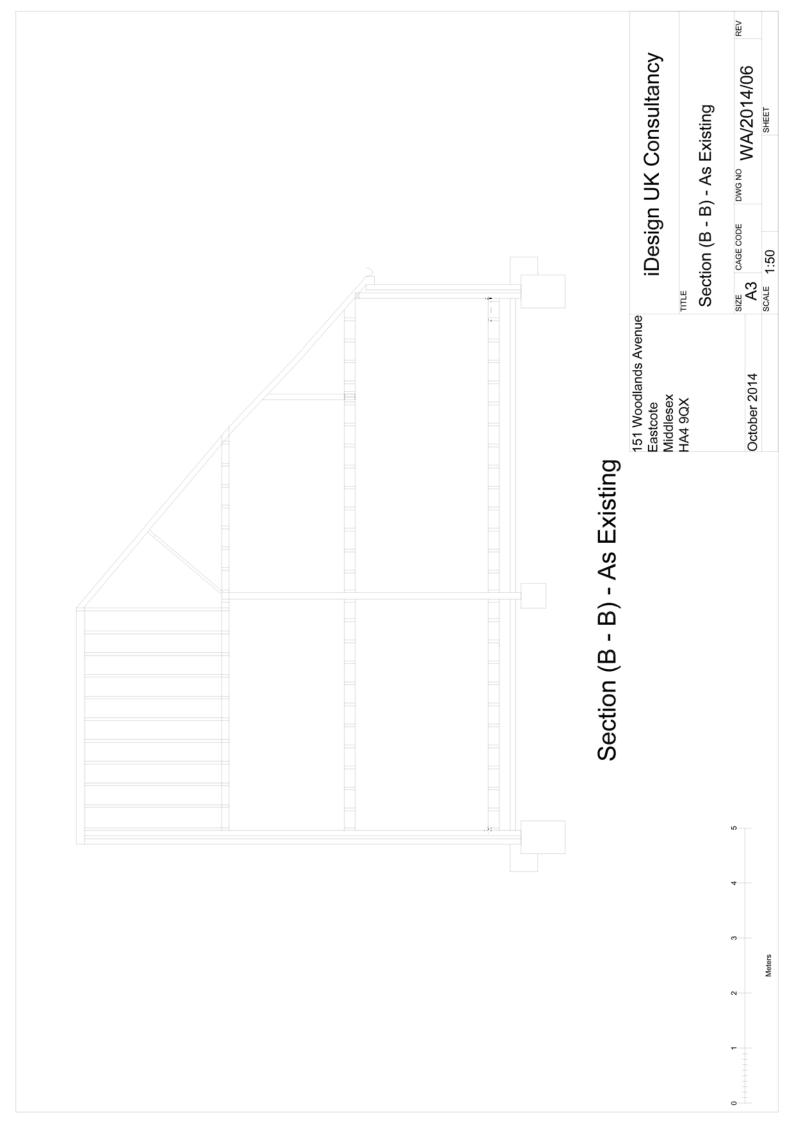



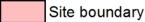

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151 Woodlands Avenue Ruislip

Planning Application Ref: 41208/APP/2014/4035

Planning Committee

North

Scale

1:1,250

March 2015

OF HILLINGDON

Residents Services Planning Section

Civic Centre, Uxbridge, Middx. UB8 1UW Telephone No.: Uxbridge 250111



Report of the Head of Planning, Sport and Green Spaces

Address LAND OPPOSITE NORTHWOOD HILLS UNITED REFORM CHURCH JOEL

STREET NORTHWOOD

Development: Removal of existing 17.5 metre telecoms pole and installation of a new 17.5


metre pole with longer shrouded section in a position 12 metres north of the

existing

LBH Ref Nos: 61384/APP/2015/196

Date Plans Received: 19/01/2015 Date(s) of Amendment(s):

Date Application Valid: 20/01/2015

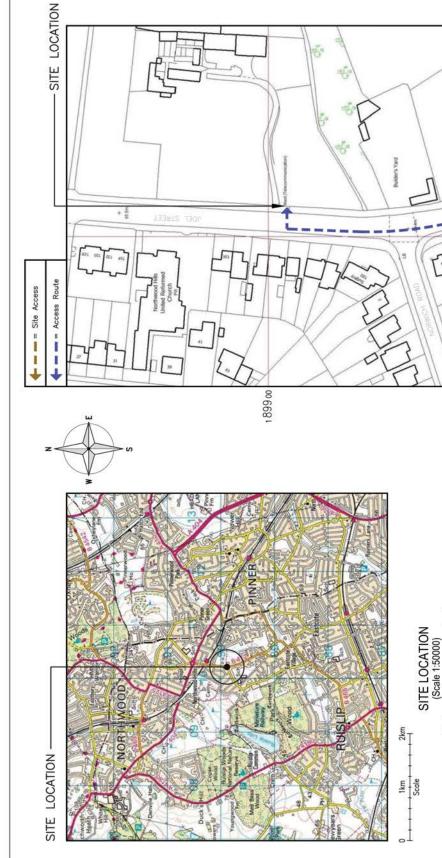

NOTES:

DIRECTIONS TO SITE:
FROM THE MAD SOUTHBOUND CONTINUE ONTO
THE A40 AND TAKE THE B467 EXIT TOWARDS
UXBRIDGE/HAREFIELD/RUISLIP/ICKENHAM. AT
THE ROUNDABOUT TAKE THE 1ST EXIT ONTO
SHARELEYS ROAD/B567. CONTINUE FOR
APPROX. 1.4 MILES AND TURN LEFT AT THE
HIGH ROAD, ICKENHAM/B466. CONTINUE TO
FOLLOW THE B466 FOR APPROX. 1.2MILES
AND TURN LEFT AT THE HIGH STREET/A4180.
AT THE ROUNDABOUT TAKE THE 33D EXIT
ONTO EASTOOTE ROAD/B466. CONTINUE FOR
APPROX. 1.3 MILES AND TURN LEFT AT JOEL
STEET/B472. CONTINUE FOR
APPROX. 1.3 MILES AND TURN LEFT AT JOEL
STEET/B472. CONTINUE FOR APPROX. 0.8
MILES AND THE SITE IS LOCATED ON THE
RIGHT HAND SIDE.

ALL DIMENSIONS ARE IN mm UNLESS NOTED OTHERWISE E: 510214 N: 189899

N.G.R

SITE LOCATION MAPS PLANNING

100

Date: 13.11.14

(Scale 1:1250)
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REV MOD	Call	WOLVEY - HINC Tel: +44 (0)14			NORTH		CTIL	145226	Site Add	6 13 49
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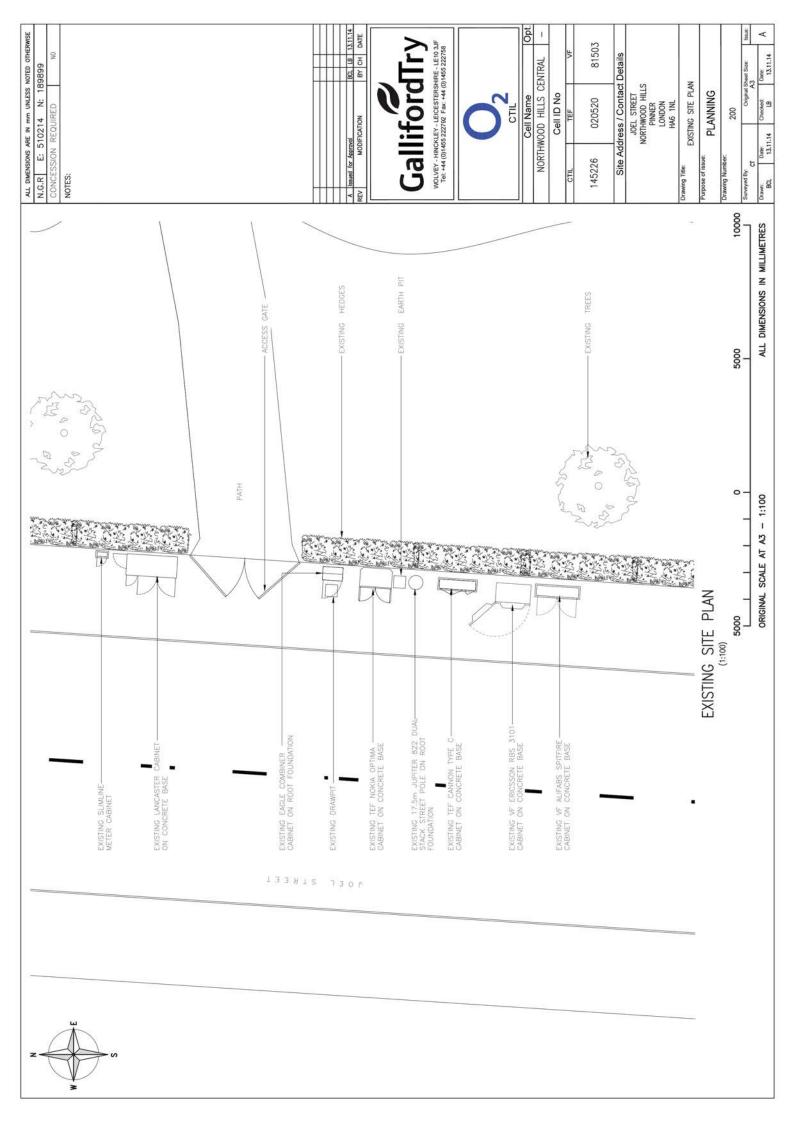
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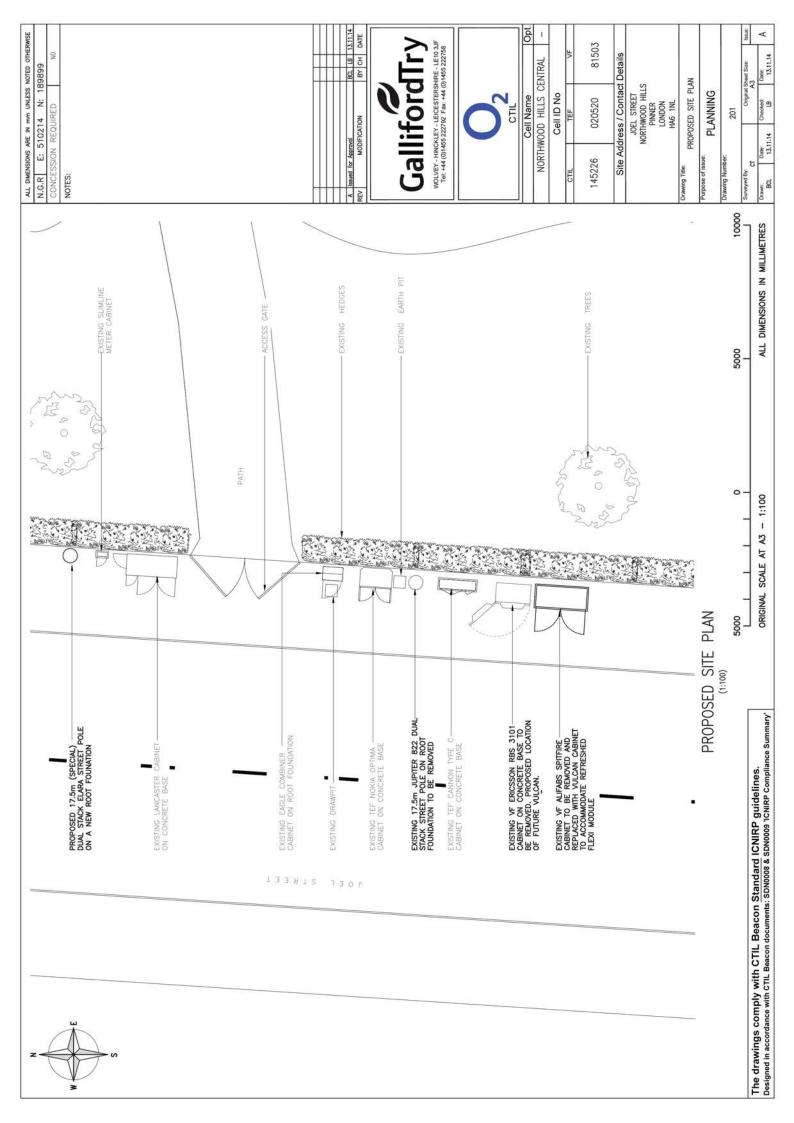
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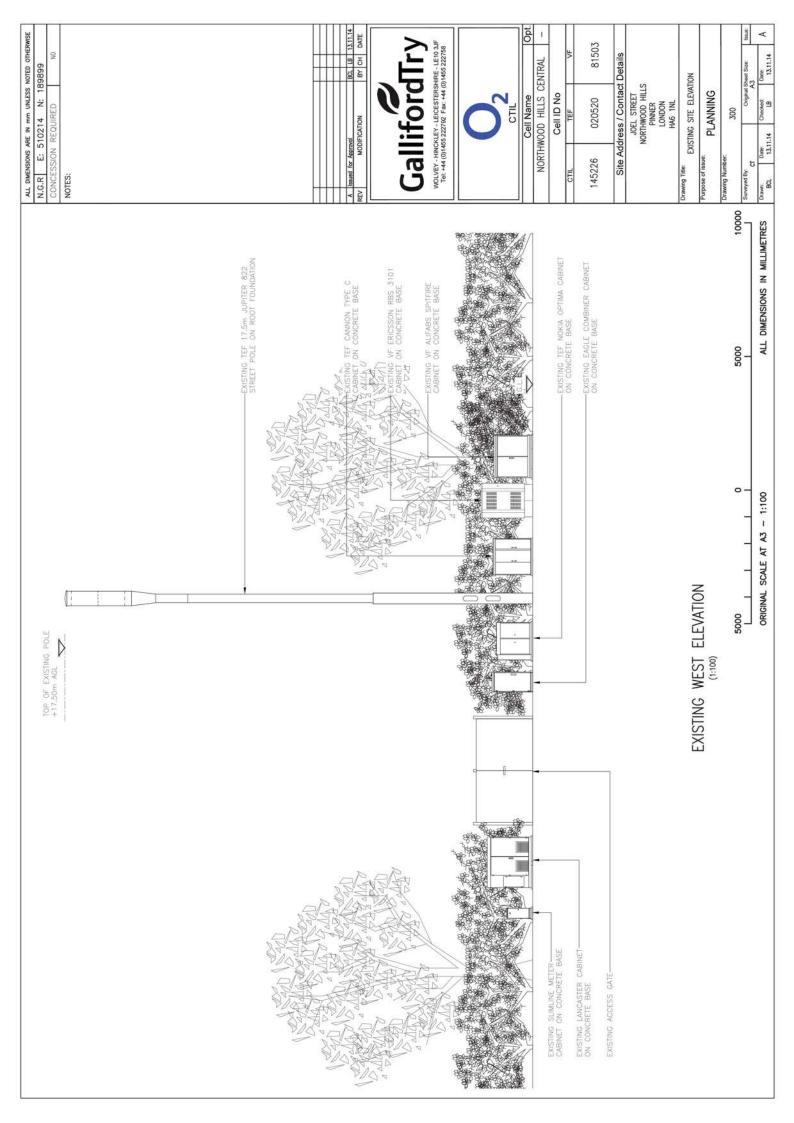
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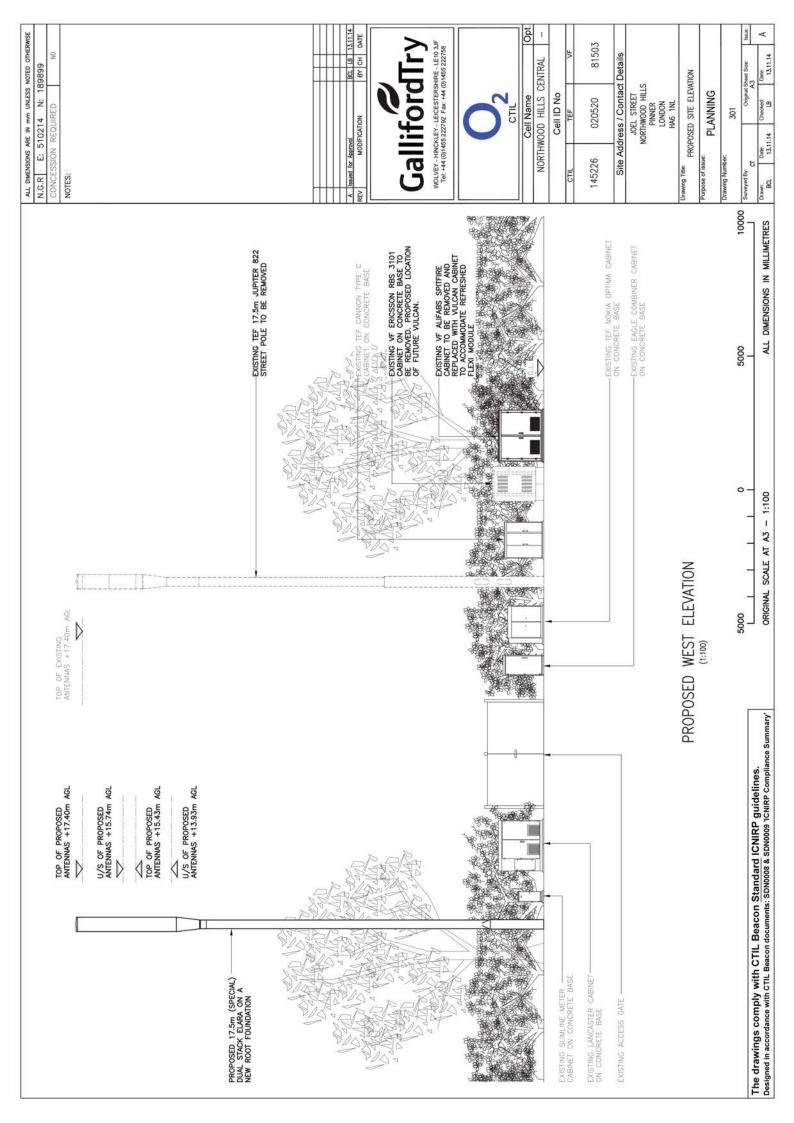
DETAILED SITE LOCATION

SITE PHOTOGRAPH










	304_260 - Vulcan
	M5 Macro - UK_SRB_3

Typical Elec. Load (W)	3654W
Power MCB	DC 50Amp
VOD	UK_SRB_304_260
RRH's	0
BTS Req.	1 x Vulcan
Option	MS

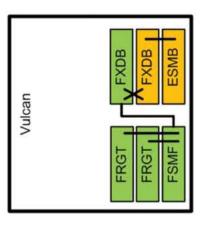

Presentation title in footer 13 November 2014


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Confidentiality level on slide master Version number on slide master

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LAYOUT

EXPANSION CABINET LAYOUT



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					FEEDER LENGTH & DIAMETER GUIDANCE NOTES	TOTAL DISTANCE MEASURED FROM MHA TO BTS CABINET, NOTE: FOR STREET POLES	THE TOTAL IS TO INCLUDE THE \$\frac{1}{8} FEEDER (TEF) & \frac{1}{2} FEEDER (VTU21) PRE-RIGGED IN THE POLE. IF FEEDER DAMETER VARIES THE LENGTHS ARE TO BE ITEMISED	SEQUENTIALLY IN THE COLUMNS FROM THE ANTENNA MHA TO THE BTS AS FOLLOWS: MAIN FEEDER, MAIN FEEDER, JUMPER 1, MAIN FEEDER, JUMPER 2, TOTAL LENGTH	
					STATUS KEY OPERATOR KEY FEEDER LENGTH & DIAMETER GUIDANCE NOTES Drawing Number:	VODAFONE	TELEFONICA		
						VF =	127		
						NEW ONTO SITE	ON SITE AND NOT BEING MOVED	ON SITE BUT BEING MOVED	REMOVED FROM SITE
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ANTENNA REFERENCE KEY

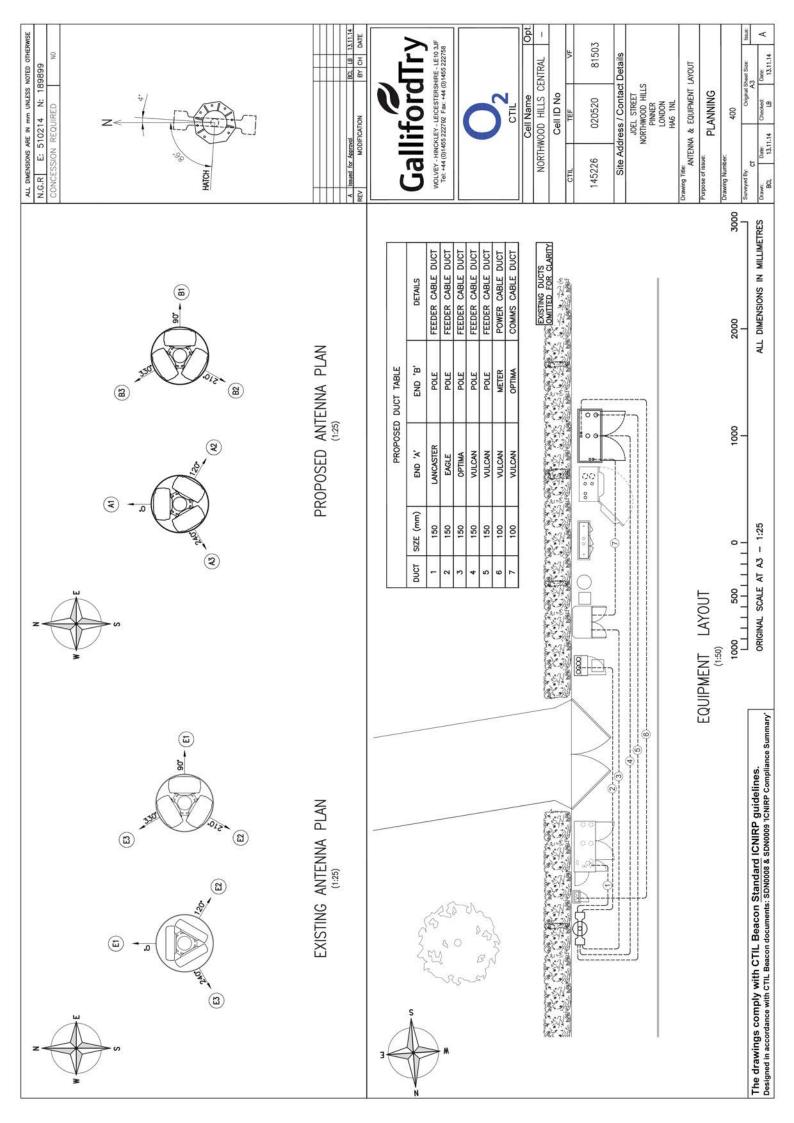	COMMENTS	2	ON NEW ROOT FOUNDATION
	STATUS	REMOVE	NEW
SUPPORT STRUCTURE KEY	COLOUR (INCLUDE RAL CODE IF NON STANDARD) & FINISH (TIMBER ETC)	GREEN	RAL 6009
SUPPORT S	TYPE	SINGLE STACK ELARA	DUAL STACK ELARA
	MANUFACTURER	HUTCHINSON ENG.	HUTCHINSON ENG.
	некнт	12.50m	15.00m
	EXISTING/ PROPOSED	EXISTING	PROPOSED

			EQU	EQUIPMENT KEY			
EXISTING/ PROPOSED	OPERATOR	MANUFACTURER	тире	SIZE (WxDxH)	COLOUR (INCLUDE RAL CODE IF NON STANDARD)	STATUS	COMMENTS
EXISTING	VF/TEF	ALIFABS	LANCASTER	1890x790x1640	RAL6009	REMAIN	
EXISTING	101	EAGLE	COMBINER CABINET	750×500×1520	RALEGOS	REMAIN	
EXISTING	坦	NOKIA	OPTIMA CABINET	1898×750×1500	RALGOOS	REMAIN	
EXISTING	13L	CANNON	TYPE 'C'	1360x352x1430	RAL6009	REMAIN	
EXISTING	W.	ERICSSON	RBS 2106	1300x725x1400	RALGOOG	REMAIN	
EXISTING:	. A/	ALIFABS	SPITFIRE	1580x380x1350	RAL6009	REMOVE	
EXISTING	1BL	NSN	G09 FSME	0.49x0.56x0.133	STANDARD	EXISTING	TNo. IN CANNON TYPE C
EXISTING	TEF	NSN	GG9 FXDA	0.49x0.56x0.133	STANDARD	EXISTING	TNo. IN CANNON TYPE C
EXISTING	世	NSN	U21 FRGF	0.49x0.56x0.133	STANDARD	EXISTING	TNo. IN OPTIMA
EXISTING	TEF	NSN	UZ1 FRGF	0.49x0.56x0.133	STANDARD	EXISTING	TNo. IN OPTIMA
EXISTING	121	NSN	LOS FRMA	0.49×0.56×0.133	STANDARD	EXISTING	ZNo. IN LANCASTER
EXISTING	TEF	NSN	LOB FSME	0.49x0.56x0.133	STANDARD	EXISTING	1No, IN LANCASTER
EXISTING	VF	NSN	GU09 FSME	0,49x0,56x0,133	STANDARD	EXISTING	2No. IN RBS 3101
EXISTING	ΛF	NSN	GU09 FXDA	0.49x0.56x0.133	STANDARD	EXISTING	2No. IN RBS 3101
EXISTING	VF	NSN	GU09 FPMA	0.49x0.56x0.133	STANDARD	EXISTING	1No. IN RBS 3101
EXISTING	VF	NSN	U21 FRGP	0.49x0.56x0.133	STANDARD	EXISTING	ZNo. IN SPITFIRE
EXISTING	VF	NSN	U21 FSME	0.49×0.56×0.133	STANDARD	EXISTING	2No. IN SPITFIRE
EXISTING	VF	NSN	U21 FPMA	0.49x0.56x0.133	STANDARD	EXISTING	1No, IN SPITFIRE
PROPOSED	VF/TEF	ALIFABS	VULCAN	1900x800x1650	RAL6009	NEW	
PROPOSED	√F	NSN	FXDB	0.49x0.56x0.133	STANDARD	NEW	2No. IN VULCAN
PROPOSED	М	NSN	ESMB	0.49x0.56x0.133	STANDARD	NEW	1No. IN VULCAN
PROPOSED	ΥF	NSN	FRGT	0.49x0.56x0.133	STANDARD	NEW	2No. IN VULCAN
000000000		00 VA 160	20000000		178070 40070 5000	100000	Deputation Control Control

	COMMENTS	WITHIN CANNON C CABINET	E
Š	STATUS	XISTING METER V	EXISTING
URCE	COLOUR (INCLUDE RAL CODE IF NON STANDARD)	GREEN	GREEN
POWER SUPPLY/SOURCE	SIZE (mm)	1360x352x1430	665x255x1015
	TYPE	TYPE C	SLIMLINE M/C
	MANUFACTURER	CANNON	ALIFABS
	OPERATOR	TEF	VF/TEF
	EXISTING/ PROPOSED	EXISTING	PROPOSED

COMMENTS	□ □	LANCASTER IF REQUIRED.	
TRANSMISSION ENCLOSURE	PROPOSED TRANSMISSION KIT LOCATION	3	1
	CURRENT TRANSMISSION KIT LOCATION	×	×
	U SPACE AVAILABLE	00	96
TRANSMISSION ENCLOSURE	TRANSMISSION SOLUTION MICROWAVE ONLY/FIBRE ONLY (WITH PROVIDER NAME)/MICROWAVE+FIBRE (WITH PROVIDER NAME)	FIBRE (BT)	FIBRE (BT)
TRANSMISSION ENCLOSURE	ENCLOSURE	OPTIMA	LANCASTER
	EXISTING/PROPOSED	EXISTING	EXISTING

EQUIPMENT SCHEDULE

Checked: Date: A

Date: 13.11.14

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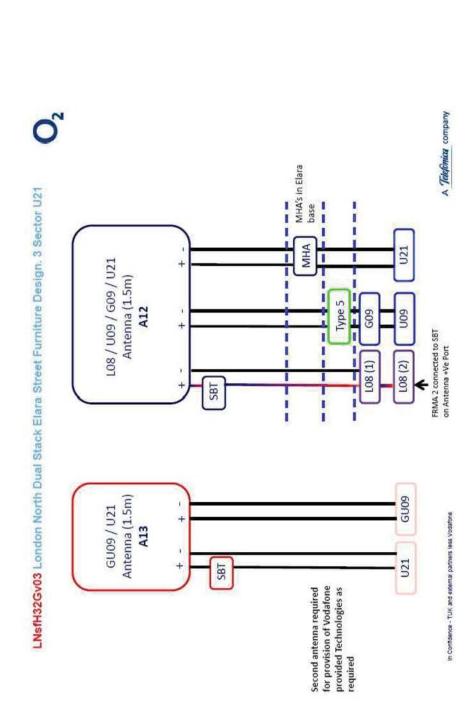
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145226

Site Address / Contact Details
JOEL STREET
NORTHWOOD HILLS
PINNER
LONDON
HAG 1NL

EQUIPMENT SCHEDULE

CALL DIRECTOR REQUIRED NG.R. E: 510214 N: 189899 NG.R. E: 510214 N: 189899 NOTES: NOTES: REFER TO CTIL DOCUMENT SDNOOD! SECTION 5.2 FOR A POPULATED EXAMPLE OF THE TABLE CHERRY PICKER SURVEY NO STAT SEARCH NO GEOTECH BUILDING REGULATIONS BUILDING REGULATIONS BUILDING REGULATIONS BUILDING REGULATIONS NO STRUCTURAL LOAD TEST NO STRUCTURAL LOAD TEST NO CENTER OF THE NO STRUCTURAL OUT TEST NO STRUCTURAL LOAD TEST NO STRUCTURAL LOAD TEST NO COMMS SERVICE ALTERATION NO SOMMS SERVICE ALTERATION NO ASBESTOS SURVEY NO COMMS SERVICE ALTERATION NO ASBESTOS SURVEY NO COMMS SERVICE ALTERATION NO COMMS SERVICE ALTERATION NO ASBESTOS SURVEY NO COMMS SERVICE ALTERATION NO COMMS SERVICE A
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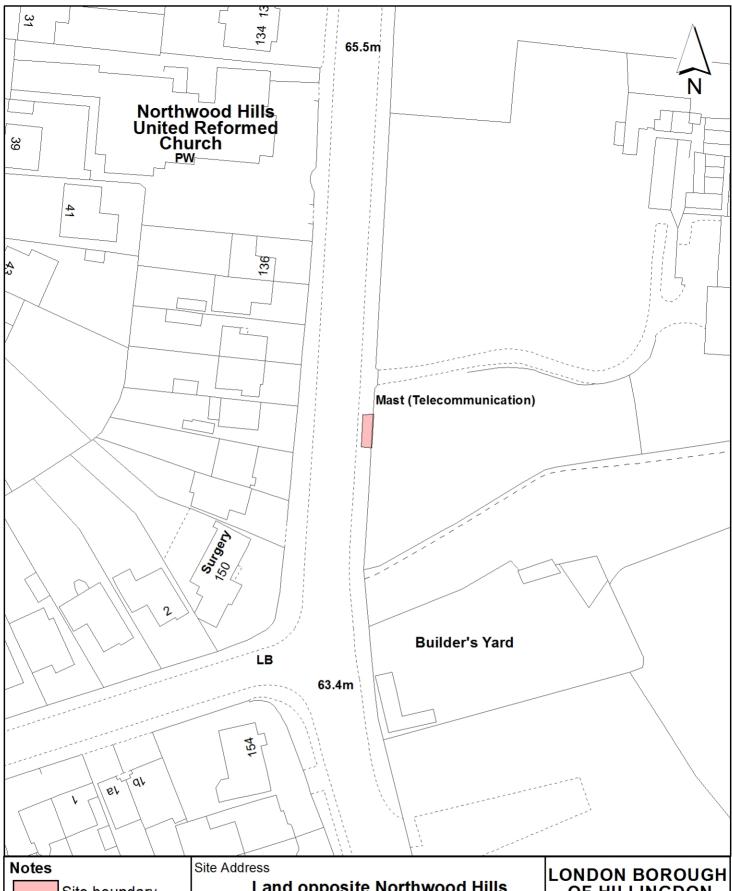



ALL DIMENSIONS ARE IN MM UNLESS NOTED OTHERWISE N.G.R E: 510214 N: 189899

NOTES:

RF SYSTEMS SCHEMATIC

13.11.14	DATE	V 10 3JF		Opt.	Ņ.		VF	81503	s					Issue	×
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	NOI		CIL C	Cell Name	HILLS	Cell ID No	TEF	020520	Address / Contact	JOEL STREET NORTHWOOD HILLS PINNER LONDON HAG 1NL	SYSTEMS SCHEMATIC	PLANNING	501	Original	Checked:
or Approval	MODIFICATION	Jallife		Ce	NORTHWOOD	ŏ	500		I te Address	JOEL NORTHW PII LO LO	RF		lber.	5	Date:
A Issued for	REV	WOLVE Tel: +4			Z		CTIL	145226	Site	1)	Drawing Title:	Purpose of issue	Drawing Number:	Surveyed By.	Drawn:



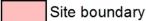

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Land opposite Northwood Hills United Reform Church Joel Street **Northwood**

Planning Application Ref: 61384/APP/2015/196 Scale

1:800

Planning Committee

North

March 2015

OF HILLINGDON

Residents Services Planning Section

Civic Centre, Uxbridge, Middx. UB8 1UW Telephone No.: Uxbridge 250111

